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STATE OF NORTH CAROLINA DIVISION OF HIGHWAYS


UTILITY CONSTRUCTION PLANS CABARRUS COUNTY


LOCATION: INTERSECTION OF SR-2894 (CONCORD MILLS BLVD.) AND ENTRANCE No. 1 KINGS GRANT PAVILION TYPE OF WORK: WATER LINE AND SEWER MAIN RELOCATIONS.

UC-1 U-5806


T.I.P. NO.

SHEET NO

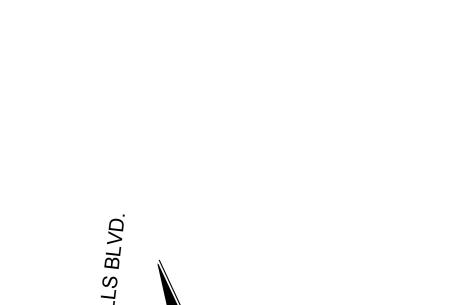

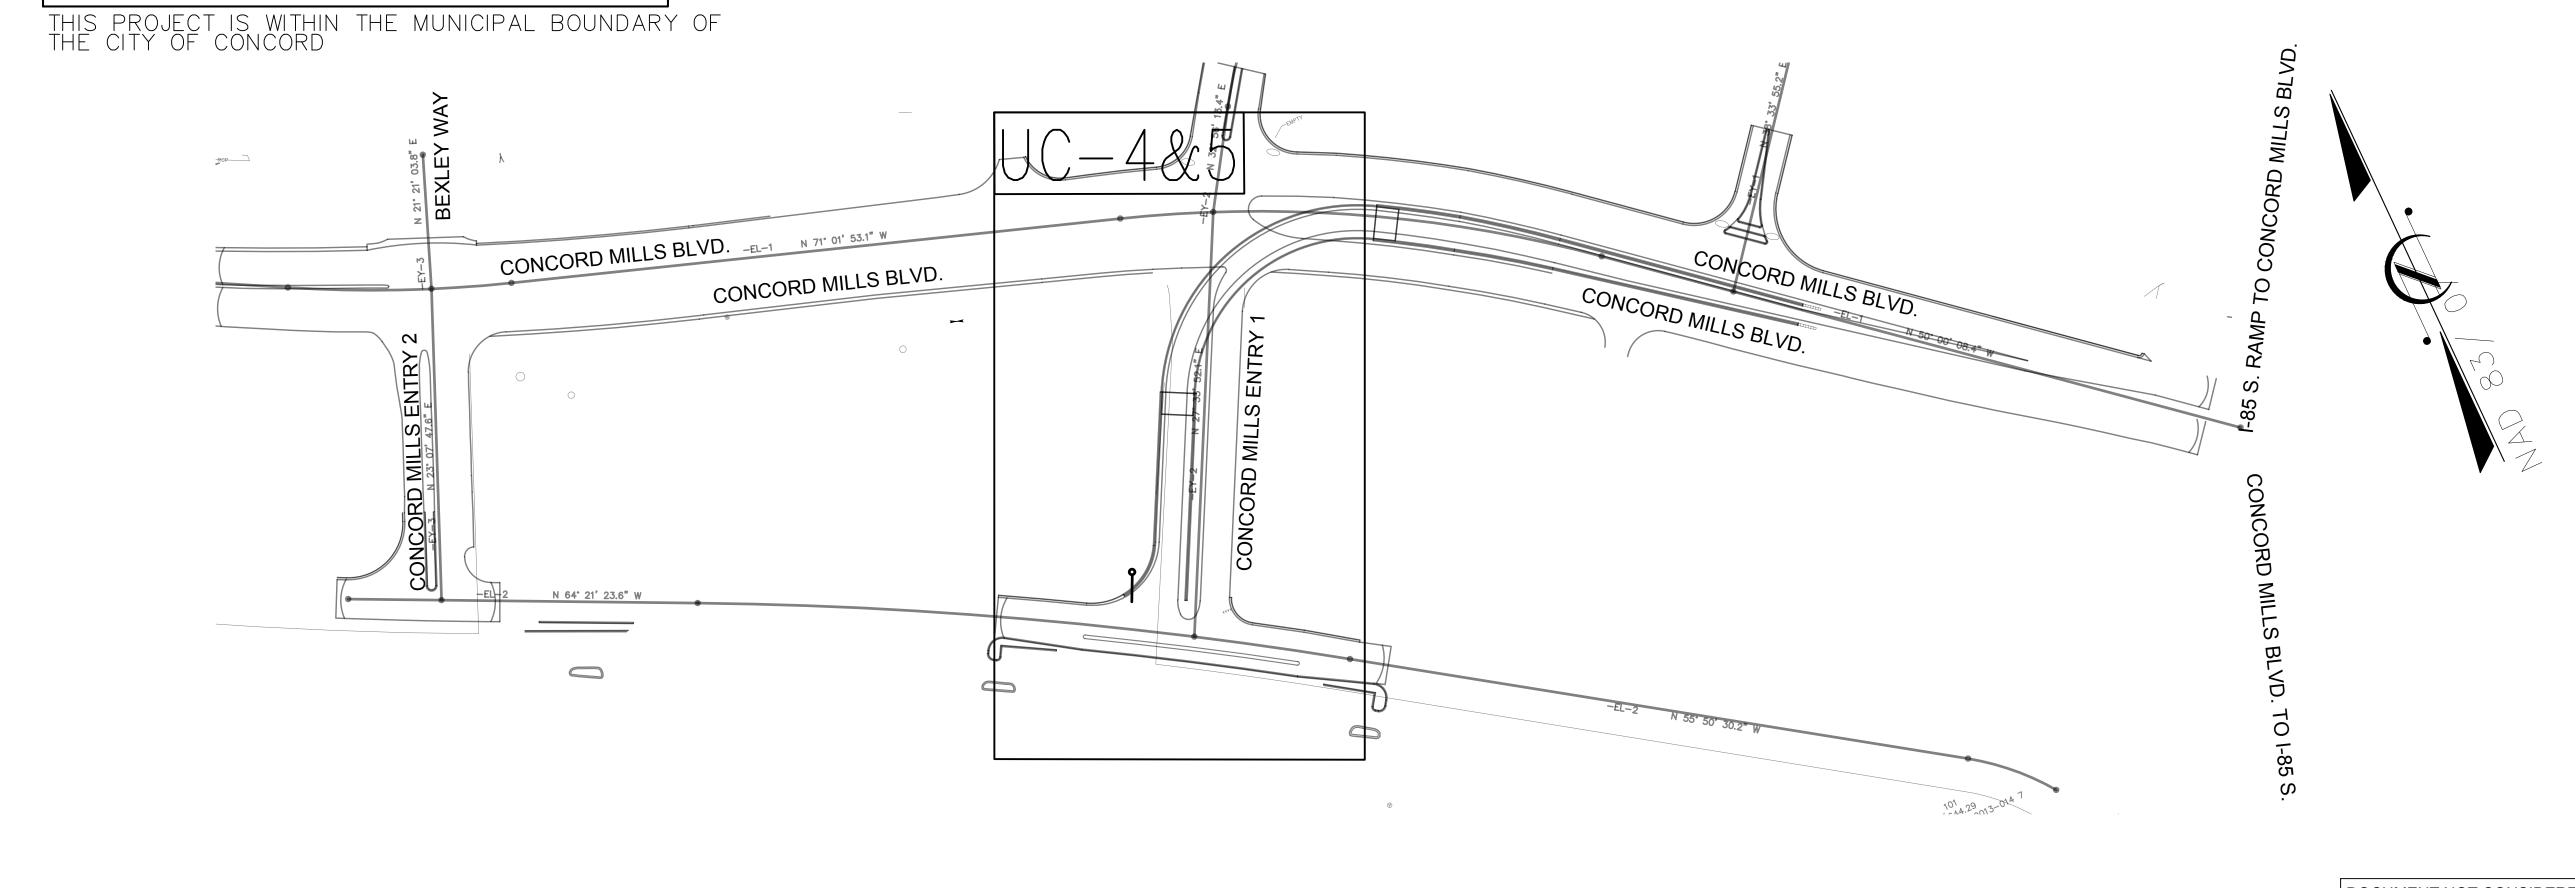

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INDEX OF SHEETS

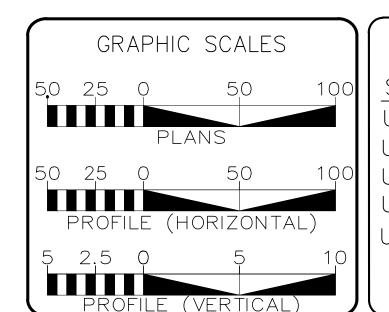SHEET NO. DESCRIPTION TITLE SHEET UTILITY/ SYMBOLOGY NOTES DETAILS UC-4 THRU UC-5 UTILITY CONSTRUCTION SHEETS


(WATER AND SEWER OWNERS) ON PROJECT

(A) WATER - CITY OF CONCORD

(B) SANITARY SEWER - CITY OF CONCORD



CITY OF CONCORD P.O. BOX 308 CONCORD N.C. 28026 (704) 920-5425 CLINTON SHOAF, P.E. - DESIGN **ENGINEER**

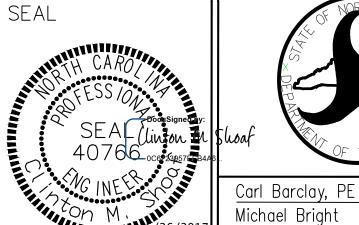

Engineer's Seal



Greg Sealy

DIVISION OF HIGHWAYS UTILITIES UNIT

1555 MAIL SERVICES CENTER RALEIGH NC 27699-1555 PHONE (919) 707-6690 FAX (919) 250-4151

UTILITIES REGIONAL ENGINEER UTILITIES ENGINEER Amy Dupree UTILITY AREA COORDINATOR UTILITY COORDINATOR

STATE OF NORTH CAROLINA DIVISION OF HIGHWAYS

JTILITIES PLAN SHEET SYMBOLS

PROPOSED WATER SYMBOLS PROPOSED MISCELLANOUS UTILITIES SYMBOLS

WATERWAY/DITCH LINE

FINOPOSED WATER STWIDGES	FIVOR
Water Line (Sized as Shown)	Power Pole
111/4 Degree Bend	Telephone Pole · · · · · · · · · · · · · · · · · · ·
221/2 Degree Bend	Joint Use Pole
45 Degree Bend	Telephone Pedestal
90 Degree Bend	Utility Line by Others (Type as Shown)
Plug	Trenchless Installation ————————————————————————————————————
Tee · · · · · · · · · · · · · · · · · ·	Encasement by Open Cut
Cross • • • • • • • • • • • • • • • • • •	Encasement
Reducer	Power Pole
Gate Valve	
Butterfly Valve	Telephone Pole
Tapping Valve	Joint Use Pole
Line Stop	Utility Pole
Line Stop with Bypass	Utility Pole with Base
Blow Off	H−Frame Pole • • • • • • • • • • • • • • • • • • •
Fire Hydrant	Power Transmission Line Tower
Relocate Fire Hydrant	Water Manhole
Remove Fire Hydrant Remove Fire Hydrant	Power Manhole · · · · · · · · · · · · · · · · · · ·
Water Meter	Telephone Manhole
	Sanitary Sewer Manhole
Relocate Water Meter Remove Water Meter Remove Water Meter	Hand Hole for Cable
	Power Transformer
Water Pump Station	Telephone Pedestal
RPZ Backflow Preventer	CATV Pedestal
DCV Backflow Preventer	Gas Valve
Relocate RPZ Backflow Preventer	Gas Meter
Relocate DCV Backflow Preventer PROPOSED ENCASEMENT PROPOSED ENCASEMENT	Located Miscellaneous Utility Object
PROPOSED SEWER SYMBOLS	Abandoned According to Utility Records · AATUR
Cravity Sower Line	End of Information
(Sized as Shown)	EIP PROPERTY LINE AND IRON PIN
(Sized as Shown)	PROPERTY LINE AND IRON PIN PROPOSED RIGHT OF WAY/PERMANENT EASEMENT
Manhole (Sized per Note)	
Sewer Pump Station	——————————————————————————————————————

Thrust Block		• • •	 	· · <u> </u>	
Air Release Va	lve		 	AR	
Utility Vault			 		
Concrete Pier			 	CP.	
Steel Pier			 	· · SP	
Plan Note			 	· · <u> </u>	► NOT
Pay Item Note			 	· · <u> </u>	NOT PA'

EXISTING UTILITIES SYMBOLS

Underground Power Line	— UE ———
*Underground Telephone Cable	UT
*Underground Telephone Conduit	— OT —
*Underground Fiber Optics Telephone Cable	— FO —
*Underground TV Cable	UTV
*Underground Fiber Optics TV Cable	
*Underground Gas Pipeline	——— G ———
Aboveground Gas Pipeline	A/G Gas
*Underground Water Line	W
Aboveground Water Line	A/G Water
*Underground Gravity Sanitary Sewer Line	SS
Aboveground Gravity Sanitary Sewer Line	/G Sanitary Sewer
*Underground SS Forced Main Line ———	— FM ———
Underground Unknown Utility Line	
SUE Test Hole	
Water Meter	
Water Valve · · · · · · · · · · · · · · · · · · ·	
Fire Hydrant	
Sanitary Sewer Cleanout	

*For Existing Utilities

Designated Utility Line (Type as Shown)

Utility Line Drawn from Record (Type as Shown)

PROJECT REFERENCE NO.	SHEET NO.	
U-5806	UC-2	

DESIGNED BY: CMS


DRAWN BY: EES

CHECKED BY: CMS

APPROVED BY:

DATE: 12/08/2016

REVISED:

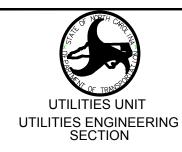


1555 MAIL SERVICES CENTEI RALEIGH NC 27699-1555 PHONE (919) 707-6690 FAX (919) 250-4151

UTILITY CONSTRUCTION

DOCUMENT NOT CONSIDERED FINAL UNLESS ALL SIGNATURES COMPLETED



PREPARED BY
ENGINEERING DEPARTMENT
CITY OF CONCORD
CABARRUS COUNTY
P.O. BOX 308
CONCORD N.C. 28026
(704) 920-5425

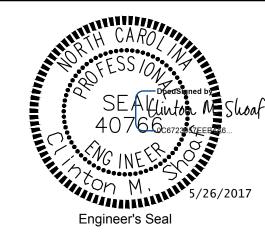

1. THE PROPOSED UTILITY CONSTRUCTION SHALL MEET THE APPLICABLE REQUIREMENTS OF THE NC DEPARTMENT OF TRANSPORTATION'S "STANDARD SPECIFICATIONS FOR ROADS AND STRUCTURES" DATED JANUARY 2012.

2. THE EXISTING UTILITIES BELONG TO CITY OF CONCORD

3. ALL WATER LINES TO BE INSTALLED WITHIN COMPLIANCE OF THE RULES AND REGULATIONS OF THE NORTH CAROLINA DEPARTMENT OF ENVIRONMENTAL AND NATURAL RESOURCES, DIVISION OF WATER RESOURCES, PUBLIC WATER SUPPLY SECTION. ALL SEWER LINES TO BE INSTALLED WITHIN COMPLIANCE OF THE RULES AND REGULATIONS OF THE NORTH CAROLINA DEPARTMENT OF ENVIRONMENT AND NATURAL RESOURCES, DIVISION OF WATER RESOURCES, WATER QUALITY SECTION. PERFORM ALL WORK IN ACCORDANCE WITH THE APPLICABLE PLUMBING CODES.

4. THE UTILITY OWNER OWNS THE EXISTING UTILITY FACILITIES AND WILL OWN THE NEW UTILITY FACILITIES AFTER ACCEPTANCE BY THE DEPARTMENT. THE DEPARTMENT OWNS THE CONSTRUCTION CONTRACT AND HAS ADMINISTRATIVE AUTHORITY. COMMUNICATIONS AND DECISIONS BETWEEN THE CONTRACTOR AND UTILITY OWNER ARE NOT BINDING UPON THE DEPARTMENT OR THIS CONTRACT UNLESS AUTHORIZED BY THE ENGINEER. AGREEMENTS BETWEEN THE UTILITY OWNER AND CONTRACTOR FOR THE WORK THAT IS NOT PART OF THIS CONTRACT OR IS SECONDARY TO THIS CONTRACT ARE ALLOWED, BUT ARE NOT BINDING UPON THE DEPARTMENT.

5. PROVIDE ACCESS FOR THE DEPARTMENT PERSONNEL AND THE OWNER'S REPRESENTATIVES TO ALL PHASES OF CONSTRUCTION. NOTIFY DEPARTMENT PERSONNEL AND THE UTILITY OWNER TWO WEEKS PRIOR TO COMMENCEMENT OF ANY WORK AND ONE WEEK PRIOR TO SERVICE INTERRUPTION. KEEP UTILITY OWNERS' REPRESENTATIVES INFORMED OF WORK PROGRESS AND PROVIDE OPPORTUNITY FOR INSPECTION OF CONSTRUCTION AND TESTING.

6. THE PLANS DEPICT THE BEST AVAILABLE INFORMATION FOR THE LOCATION, SIZE, AND TYPE OF MATERIAL FOR ALL EXISTING UTILITIES. MAKE INVESTIGATIONS FOR DETERMINING THE EXACT LOCATION, SIZE, AND TYPE MATERIAL OF THE EXISTING FACILITIES AS NECESSARY FOR THE CONSTRUCTION OF THE PROPOSED UTILITIES AND FOR AVOIDING DAMAGE TO EXISTING FACILITIES. REPAIR ANY DAMAGE INCURRED TO EXISTING FACILITIES TO THE ORIGINAL OR BETTER CONDITION AT NO ADDITIONAL COST TO THE DEPARTMENT.

7. MAKE FINAL CONNECTIONS OF THE NEW WORK TO THE EXISTING SYSTEM WHERE INDICATED ON THE PLANS, AS REQUIRED TO FIT THE ACTUAL CONDITIONS, OR AS DIRECTED.

8. MAKE CONNECTIONS BETWEEN EXISTING AND PROPOSED UTILITIES AT TIMES MOST CONVENIENT TO THE PUBLIC, WITHOUT ENDANGERING THE UTILITY SERVICE, AND IN ACCORDANCE WITH THE UTILITY OWNER'S REQUIREMENTS. MAKE CONNECTIONS ON WEEKENDS, AT NIGHT, AND ON HOLIDAYS IF NECESSARY.

9. ALL UTILITY MATERIALS SHALL BE APPROVED PRIOR TO DELIVERY TO THE PROJECT. SEE 1500-7, "SUBMITTALS AND RECORDS" IN SECTION 1500 OF THE STANDARD SPECIFICATIONS.

PROJECT SPECIFIC NOTES:

- 1. PROPOSED WATER LINE FROM STATION 0+00 TO STATION 5+31 SHALL BE D.I.R.J. AND HDPE (DUCTILE IRON RESTRAINED JOINT AND HIGH DENSITY POLYETHYLENE) PIPE.
- 2. PROPOSED SANITARY SEWER LINE FROM STATION 3+30 TO STATION 3+70 SHALL BE PVC (POLYVINYL CHLORIDE)

3. CONTRACTOR'S ATTENTION IS DIRECTED TO SECTIONS 102, 107, AND 1550 OF THE STANDARD SPECIFICATIONS CONCERNING TRENCHLESS INSTALLATION. IT IS CONTRACTOR'S RESPONSIBILITY TO HAVE BORE DESIGNED AND SEALED BY A LICENSED NORTH CAROLINA PROFESSIONAL ENGINEER. NO DAMAGE IS ALLOWED TO RIVER, WETLANDS, OR BUFFER ZONES.

4. IF HDPE PIPE IS INSTALLED BY DIRECTIONAL DRILL. IT SHALL BE FILLED WITH WATER AND NOT BE CONNECTED TO ANY OTHER PIPE OR FITTINGS FOR ONE WEEK FROM THE TIME OF INSTALLATION.

LIST OF STANDARD DETAILS

SEE SHEET UC-3A

1. ALL CITY OF CONCORD PUBLIC UTILITY EXTENSIONS AND SERVICE MATERIALS, EQUIPMENT, LABOR AND WORKMANSHIP SHALL BE IN ACCORDANCE WITH AND SUBJECT TO THE WATER AND SEWER AUTHORITIES OF CABARRUS COUNTY'S STANDARD SPECIFICATIONS: THE CITY OF CONCORD'S ORDINANCES. POLICIES AND STANDARD SPECIFICATIONS AND THE NORTH CAROLINA ADMINISTRATIVE CODE FOR WASTEWATER COLLECTION AND WATER DISTRIBUTION SYSTEMS. IN THE EVENT OF CONFLICT BETWEEN THE WATER AND SEWER AUTHORITY OF CABARRUS COUNTY'S STANDARD SPECIFICATIONS: THE CITY OF CONCORD'S ORDANCES. POLICIES. AND STANDARD SPECIFICATIONS OR THE NORTH CAROLINA ADMINISTRATIVE CODE. THE MORE RESTRICTIVE REQUIREMENTS SHALL APPLY.

2. ALL WATER LINES TO BE INSTALLED WITHIN COMPLIANCE OF THE RULES AND REGULATIONS OF THE NORTH CAROLINA DEPARTMENT OF ENVIRONMENTAL AND NATURAL RESOURCES, DIVISION OF WATER RESOURCES,

PUBLIC WATER SUPPLY SECTION. ALL SEWER LINES TO BE INSTALLED WITHIN COMPLIANCE OF THE RULES AND REGULATIONS OF THE NORTH CAROLINA DEPARTMENT OF ENVIRONMENT AND NATURAL RESOURCES, DIVISION OF WATER RESOURCES, WATER QUALITY SECTION. PERFORM ALL WORK IN ACCORDANCE WITH THE APPLICABLE PLUMBING CODES.

3. THE UTILITY OWNER OWNS THE EXISTING UTILITY FACILITIES AND WILL OWN THE NEW UTILITY FACILITIES AFTER ACCEPTANCE BY THE DEPARTMENT. THE DEPARTMENT OWNS THE CONSTRUCTION CONTRACT AND HAS ADMINISTRATIVE AUTHORITY. COMMUNICATIONS AND DECISIONS BETWEEN THE CONTRACTOR AND UTILITY OWNER ARE NOT BINDING UPON THE DEPARTMENT OR THIS CONTRACT UNLESS AUTHORIZED BY THE ENGINEER. AGREEMENTS BETWEEN THE UTILITY OWNER AND CONTRACTOR FOR THE WORK THAT IS NOT PART OF THIS CONTRACT OR IS SECONDARY TO THIS CONTRACT ARE ALLOWED, BUT ARE NOT BINDING UPON THE DEPARTMENT.

4. PROVIDE ACCESS FOR THE DEPARTMENT PERSONNEL AND THE OWNER'S REPRESENTATIVES TO ALL PHASES OF CONSTRUCTION. NOTIFY DEPARTMENT PERSONNEL AND THE UTILITY OWNER TWO WEEKS PRIOR TO COMMENCEMENT OF ANY WORK AND ONE WEEK PRIOR TO SERVICE INTERRUPTION. KEEP UTILITY OWNERS' REPRESENTATIVES INFORMED OF WORK PROGRESS AND PROVIDE OPPROTUNITY FOR INSPECTION OF CONSTRUCTION AND TESTING.

5. THE PLANS DEPICT THE BEST AVAILABLE INFORMATION FOR THE LOCATION, SIZE, AND TYPE OF MATERIAL FOR ALL EXISTING UTILITIES. MAKE INVESTIGATIONS FOR DETERMINING THE EXACT LOCATION, SIZE, AND TYPE MATERIAL OF THE EXISTING FACILITIES AS NECESSARY FOR THE CONSTRUCTION OF THE PROPOSED UTILITIES AND FOR AVOIDING DAMAGE TO EXISTING FACILITIES. REPAIR ANY DAMAGE INCURRED TO EXISTING FACILITIES TO THE ORIGINAL OR BETTER CONDITION AT NO ADDITONAL COST TO THE DEPARTMENT.

6. MAKE FINAL CONNECTIONS OF THE NEW WORK TO THE EXISTING SYSTEM WHERE INDICATED ON THE PLANS, AS REQUIRED TO FIT THE ACTUAL CONDITIONS, OR AS DIRECTED.

7. MAKE CONNECTIONS BETWEEN EXISTING AND PROPOSED UTILITIES AT TIMES MOST CONVENIENT TO THE PUBLIC, WITHOUT ENDANGERING THE UTILITY SERVICE, AND IN ACCORDANCE WITH THE UTILITY OWNER'S REQUIREMENTS. MAKE CONNECTIONS ON WEEKENDS, AT NIGHT, AND ON HOLIDAYS IF NECESSARY.

8. ALL UTILITY MATERIALS SHALL BE APPROVED PRIOR TO DELIVERY TO THE PROJECT. SEE 1500-7, "SUBMITTALS AND RECORDS" IN SECTION 1500 OF THE STANDARD SPECIFICATIONS. (2012)

CONSTRUCTION SEQUENCE

- 1. CONTRACTOR SHALL ENSURE THAT ALL NECESSARY PERMITS HAVE BEEN RECEIVED AND THAT THOSE REQUIRED TO BE DISPLAYED ON-SITE ARE AVAILABLE.
- 2. CONTRACTOR SHALL HOLD PRE-CONSTRUCTION MEETING AT LEAST 48 HOURS BEFORE THE ACTUAL START OF CONSTRUCTION.
- 3. CONTRACTOR SHALL CONTACT CAROLINA ONE CALL AND ALL ENTITIES HAVING BURIED UTILITIES AT LEAST 72 HOURS PRIOR TO DIGGING OR AS DIRECTED AT THE PRE-CONSTRUCTION MEETING.
- 4. CONTRACTOR SHALL MAINTAIN TRAFFIC AND SAFETY CONTROL MEASURES AT ALL TIMES ON THE PROJECT. (SEE TRAFFIC CONTROL.)

5. CONTRACTOR SHALL INSTALL TEMPORARY CONSTRUCTION ENTRANCES (IF ANY) AT EACH POINT OF ACCESS TO STORAGE AND CONSTRUCTION AREAS.

DESIGNED BY: CMS DRAWN BY: EES CHECKED BY: CMS DATE: 12/08/2016

PROJECT REFERENCE NO.

U - 5806

APPROVED BY:

REVISED:

UTILITIES UNIT UTILITIES ENGINEERING SECTION

SHEET NO.

UC-3

1555 MAIL SERVICES CENTER RALEIGH NC 27699-1555 PHONE (919) 707-6690 FAX (919) 250-4151

UTILITY CONSTRUCTION

DOCUMENT NOT CONSIDERED FINAL UNLESS ALL SIGNATURES COMPLETED

- 6. SEDIMENT AND EROSION CONTROL MEASURES SHALL BE INSTALLED IN ACCORDANCE WITH PLANS AND BEFORE STARTING WORK.
- 7. CONTRACTOR SHALL CLEAR RIGHT-OF-WAY IF NECESSARY.
- 8. STOCKPILE RIP-RAP ON SITE AND INSTALL ALL OTHER EROSION CONTROL MEASURES WHERE THE WORK IS OCCURRING. THE CONTRACTOR SHALL NOT INSTALL EROSION CONTROL MEASURES IN AREAS WHERE THE WORK WILL NOT OCCUR FOR SOME TIME. ADDITIONAL EROSION CONTROL MEASURES MAY BE REQUIRED BY THE CITY/PROJECT ENGINEER OR UPON RECOMMENDATION OF NC DENR PERSONNEL AS CONDITIONS WARRANT.
- 9. IN AREAS WHERE IT IS NOT FEASIBLE TO INSTALL EROSION CONTROL DEVICES, ALL DISTURBED AREAS MUST BE SEEDED AND MULCHED BY THE CONTRACTOR WITHIN THREE DAYS OF INITIAL DISTURBANCE. TEMPORARY SEEDING SHALL BE REQUIRED ON ALL OTHER AREAS TO BE DISTURBED FOR A PERIOD OF 10 DAYS OR LONGER.
- 10. CONTRACTOR SHALL COORDINATE ALL BLOW-OFFS AND TESTING WITH THE CITY ENGINEERING DEPARTMENT'S CONSTRUCTION ADMINISTRATOR AT LEAST 24 HOURS IN ADVANCE OF SUCH WORK. NOTIFY THE RESPONSE AREA FIRE DEPARTMENT IF EXISTING SYSTEM VALVES NEED TO BE SHUT OFF IN THE COURSE OF THE WORK.
- 11. UPON COMPLETION OF THE INSTALLATION AND WITH APPROVAL OF NC DENR-DLR, ALL EROSION CONTROL DEVICES EXCEPT FOR CREEK/STREAM BANK STABILIZATION SHALL BE REMOVED AND DISPOSED OF IN AN ACCEPTABLE MANNER. EACH SECTION SHALL BE SEEDED AT EARLIEST POSSIBLE DATE AFTER INSTALLATION OF PIPE, STRUCTURE, OR ACCESS.
- 12. ONCE GROUND COVER IS FIRMLY ESTABLISHED, ALL TEMPORARY EROSION CONTROL MEASURES SHALL BE REMOVED WITH THE APPROVAL OF NC DENR-DLR.
- 13. CONTRACTOR SHALL REFERENCE SPECIAL CONDITIONS FOR JOB SEQUENCE AND OTHER DIRECTIONS, IF ANY. CONTRACTOR SHALL COORDINATE CONSTRUCTION ACTIVITY WITH THE CITY ENGINEERING DEPARTMENT.

GENERAL NOTES


- 1. ALL MATERIALS, EQUIPMENT, LABOR, AND WORKMANSHIP IS TO BE IN ACCORDANCE WITH AND SUBJECT TO THE WATER AND SEWER AUTHORITY OF CABARRUS COUNTY'S STANDARD SPECIFICATIONS; THE CITY OF CONCORD'S ORDINANCES, POLICIES, AND STANDARD SPECIFICATIONS, AND NCDOT STANDARD SPECIFICATIONS, AND THE NORTH CAROLINA ADMINISTRATIVE CODE FOR WASTEWATER COLLECTION AND WATER DISTRIBUTION SYSTEMS. IN THE EVENT OF CONFLICT BETWEEN THE WATER AND SEWER AUTHORITY OF CABARRUS COUNTY'S STANDARD SPECIFICATION; THE CITY OF CONCORD'S ORDINANCES, POLICIES, AND STANDARD SPECIFICATIONS, AND NCDOT STANDARD SPECIFICATIONS, OR THE NORTH CAROLINA ADMINISTRATIVE CODE, THE MORE RESTRICTIVE REQUIREMENTS SHALL APPLY.
- 2. ALL SEDIMENT AND EROSION CONTROL MEASURES SHALL CONFORM TO THE LATEST STANDARDS OF THE N.C. SEDIMENTATION POLLUTION CONTROL ACT AND APPLICABLE LOCAL AND FEDERAL REQUIREMENTS.
- 3. CONTRACTOR SHALL NOTIFY THE CONSTRUCTION ADMINISTRATOR OF THE CITY OF CONCORD ENGINEERING DEPARTMENT AT LEAST 48 HOURS IN ADVANCE OF BEGINNING WORK.
- 4. INDIVIDUAL WATER, GAS, SEWER, TELEPHONE, AND CABLE SERVICES MAY OR MAY NOT BE SHOWN ON THE PLANS. CONTRACTOR TO CONTACT APPROPRIATE AGENCY FOR FIELD LOCATIONS.
- 5. CITY OF CONCORD ELECTRIC, WATER, AND SEWER DEPARTMENT PERSONNEL WILL ASSIST THE CONTRACTOR IN LOCATING ALL CITY OF CONCORD UTILITY SERVICES AND LINES.
- 6. IF MAILBOX PULL-OFF AREAS ARE DISTURBED, CRUSHED STONE STABILIZER SHALL BE PLACED WITH SUFFICIENT LENGTH TO ACCOMMODATE VEHICULAR TRAFFIC. THESE AREAS SHALL BE MAINTAINED FOR THE ONE-YEAR WARRANTY PERIOD. THE COST OF THESE ITEMS SHALL BE INCLUDED IN THE COST OF LAYING PIPE.
- 7. THIS PROJECT IS NOT SUBJECT TO 100 YEAR FLOOD PER FIRM MAP 3710458900K, MARCH 2,
- 8. FIRE HYDRANT EXTENSIONS, IF NEEDED, SHALL BE INCLUDED IN THE COST OF THE HYDRANT INSTALLATION.
- 9. GATE OR BUTTERFLY VALVES, BLOW-OFFS, AND FIRE HYDRANTS MAY BE FIELD ADJUSTED 50 FEET IN EITHER DIRECTION WITH THE PERMISSION OF THE ENGINEERING AND WATER RESOURCES DEPARTMENTS.


RIGHT-OF-WAY NOTES


- 1. RIGHT-OF-WAY LINES AND PROPERTY LINES ARE SHOWN ON THE DESIGN DRAWINGS AND ARE FOR REFERENCE ONLY. FOR EXACT LOCATIONS REFER TO THE SURVEY PLATS BY THE CITY OF CONCORD'S CONSULTING REGISTERED LAND SURVEYOR OR BY THE CITY SURVEYOR.
- 2. REFER TO STANDARDS AND SPECIFICATIONS FOR WATER AND SEWER CONSTRUCTION FOR FURTHER DETAILS CONCERNING THE RIGHT-OF-WAY.





PREPARED BY ENGINEERING DEPARTMENT CITY OF CONCORD CABARRUS COUNTY P.O. BOX 308 CONCORD N.C. 28026 (704) 920-5425

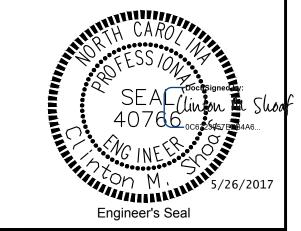


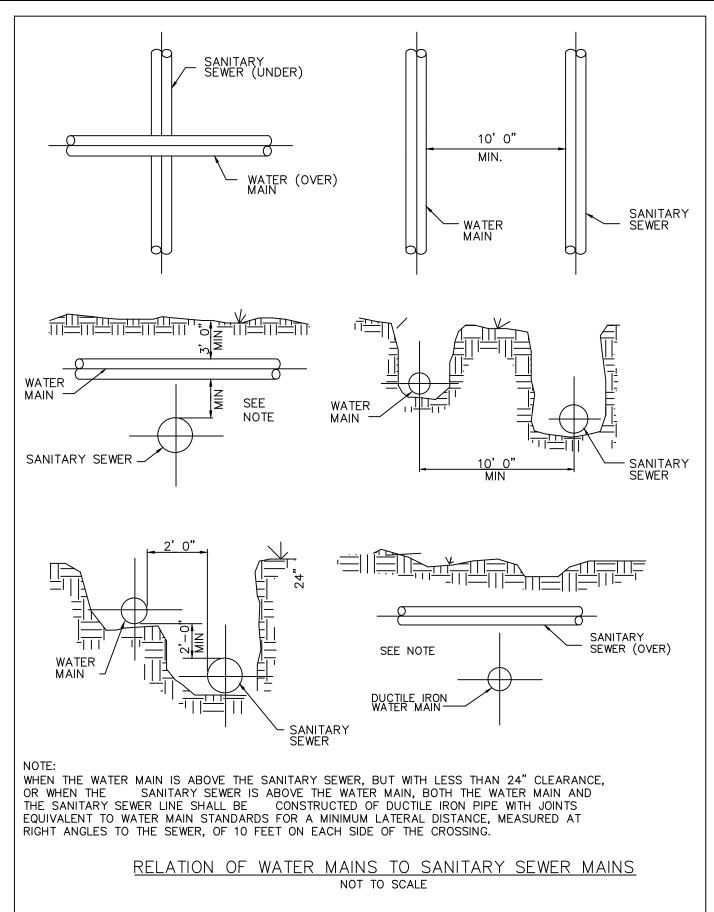


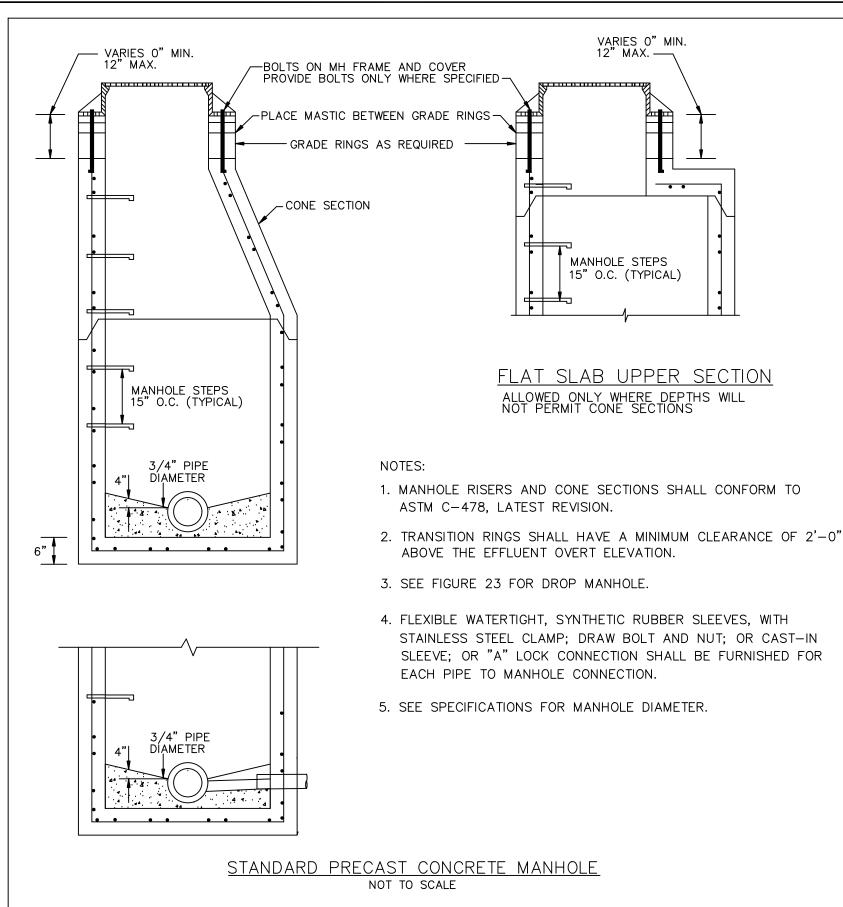

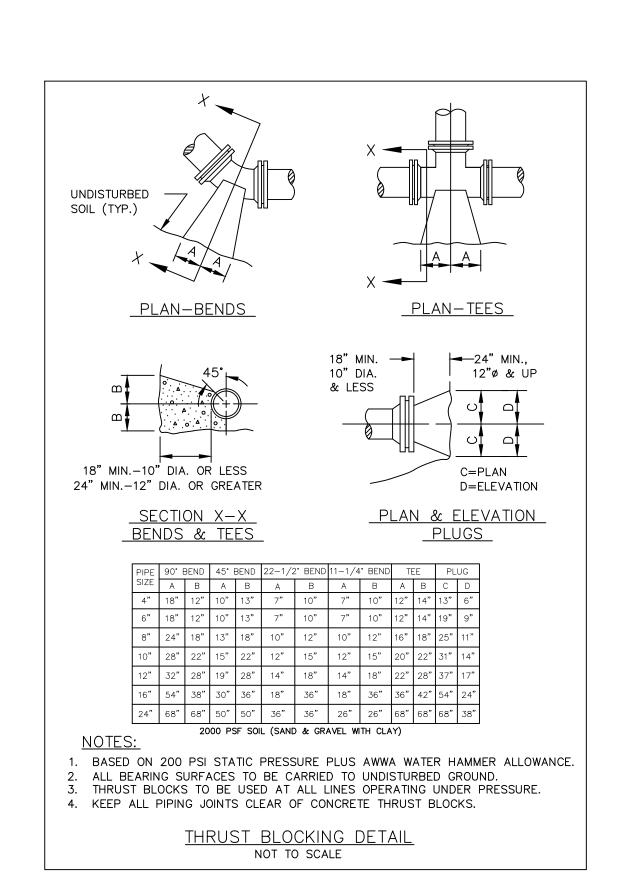

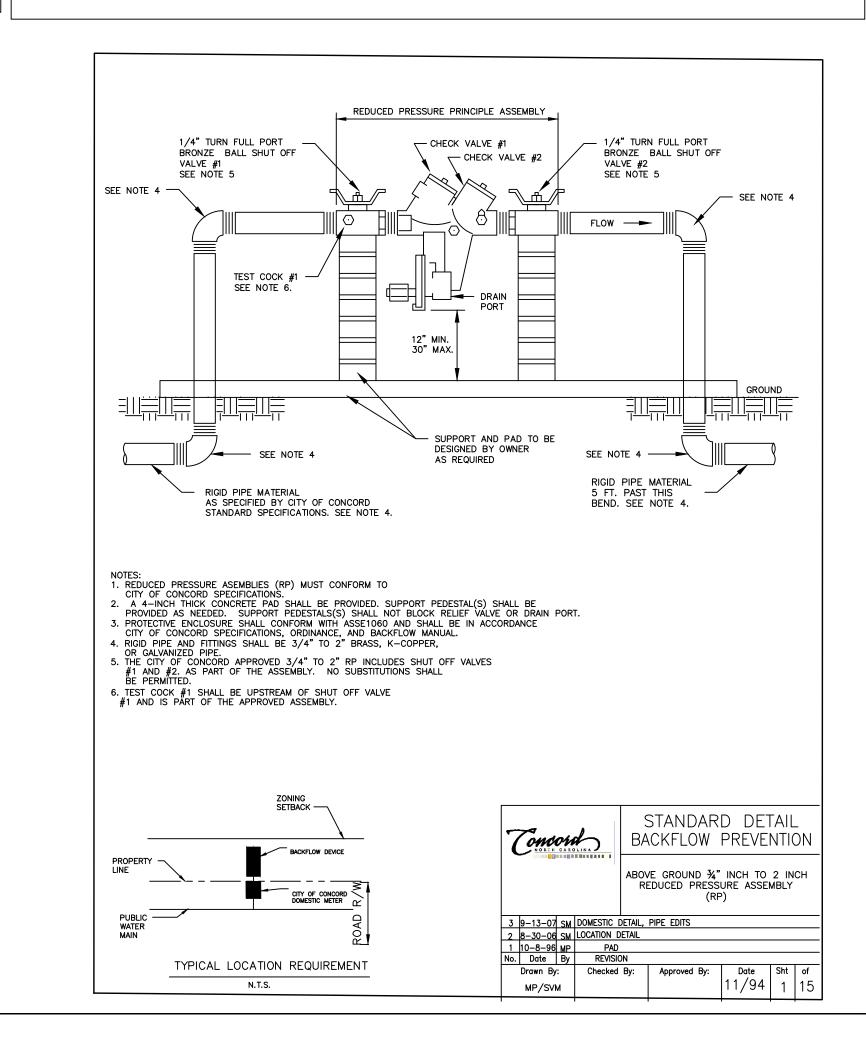


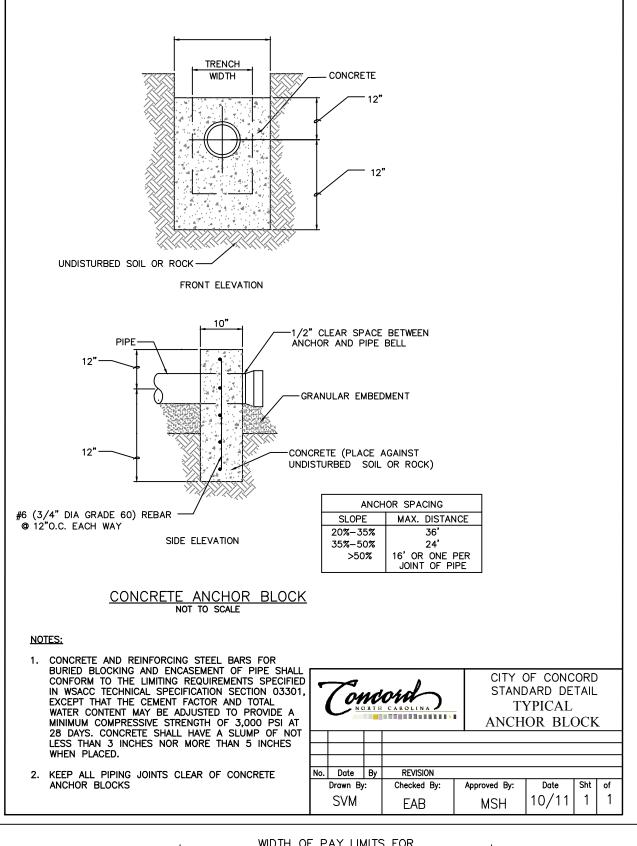


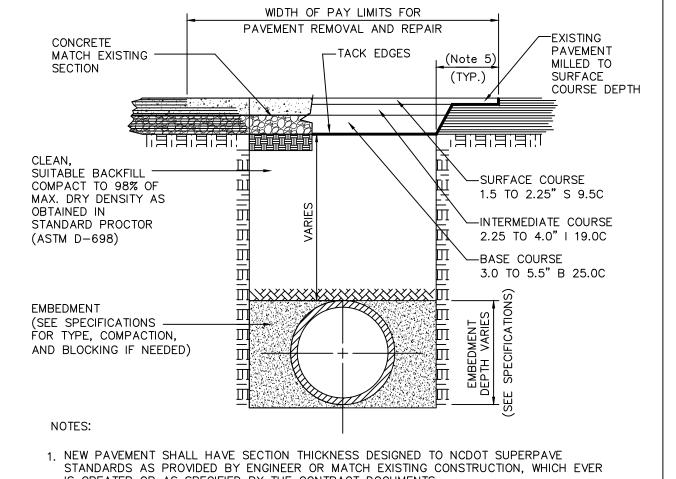


- IS GREATER OR AS SPECIFIED BY THE CONTRACT DOCUMENTS.
- 2. TRENCH IS TO BE BACKFILLED IN COMPACTED 6" LAYERS BEFORE PAVEMENT REPAIRS ARE MADE.
- 3. REFER TO EARTHWORK SPECIFICATIONS FOR EMBEDMENT AND FILL REQUIREMENTS.
- 4. THIS DETAIL SHOWS ASPHALT PAVEMENT REPLACEMENT. THE WIDTH OF PAY LIMITS SHALL APPLY TO STONE AND CONCRETE PAVEMENT AS WELL.
- 5. 18" MIN. AROUND PATCHES AND 36" MIN. AT CURB CUTS.

UTILITY CUT REPLACEMENT DETAIL SCALE: NONE

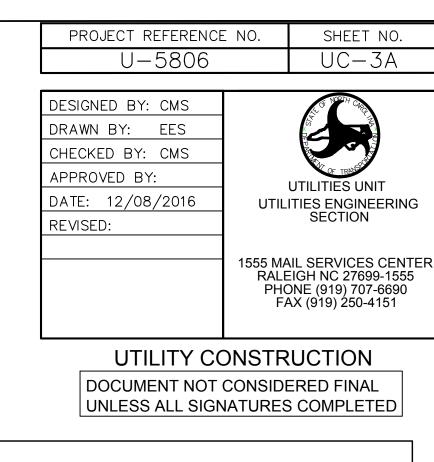


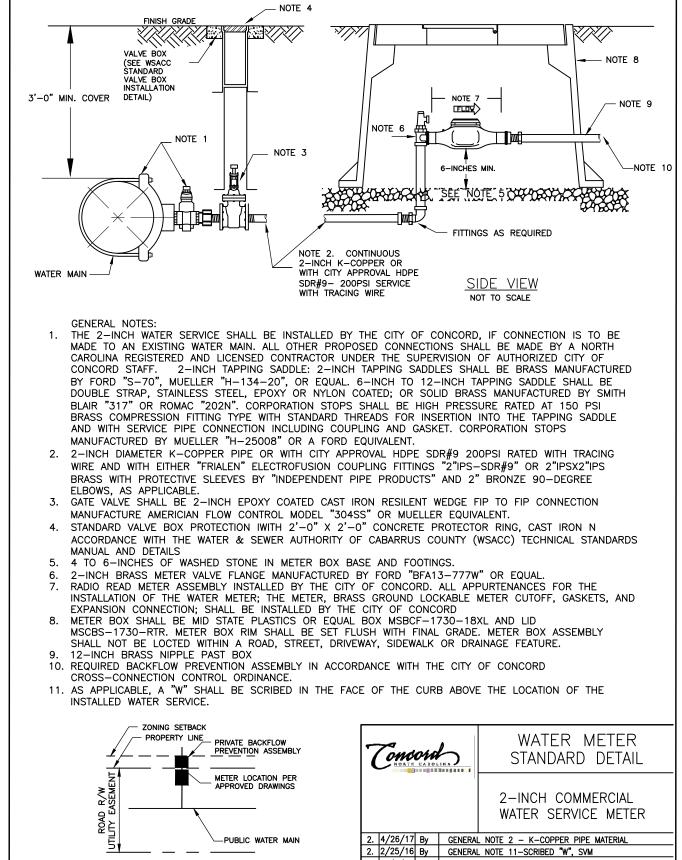

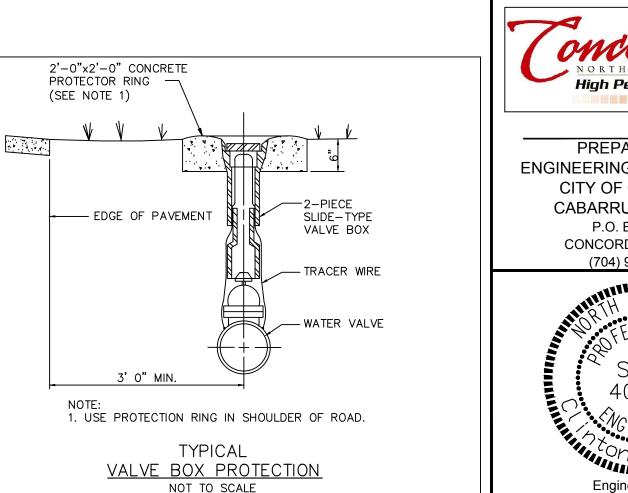

GENERAL LOCATION REQUIREMENT

N.T.S.

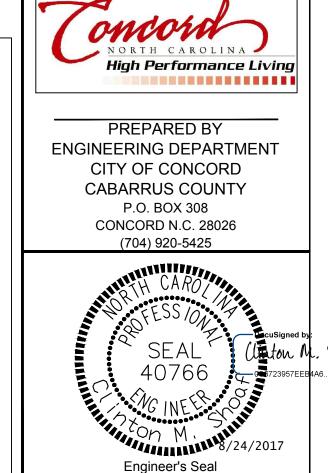


 1.
 9/7/07
 By
 CONTINUOUS PIPE & CONNECTION, SVM


 No.
 Date
 By
 REVISION

Checked By: Approved By: Date Sht of

03/06

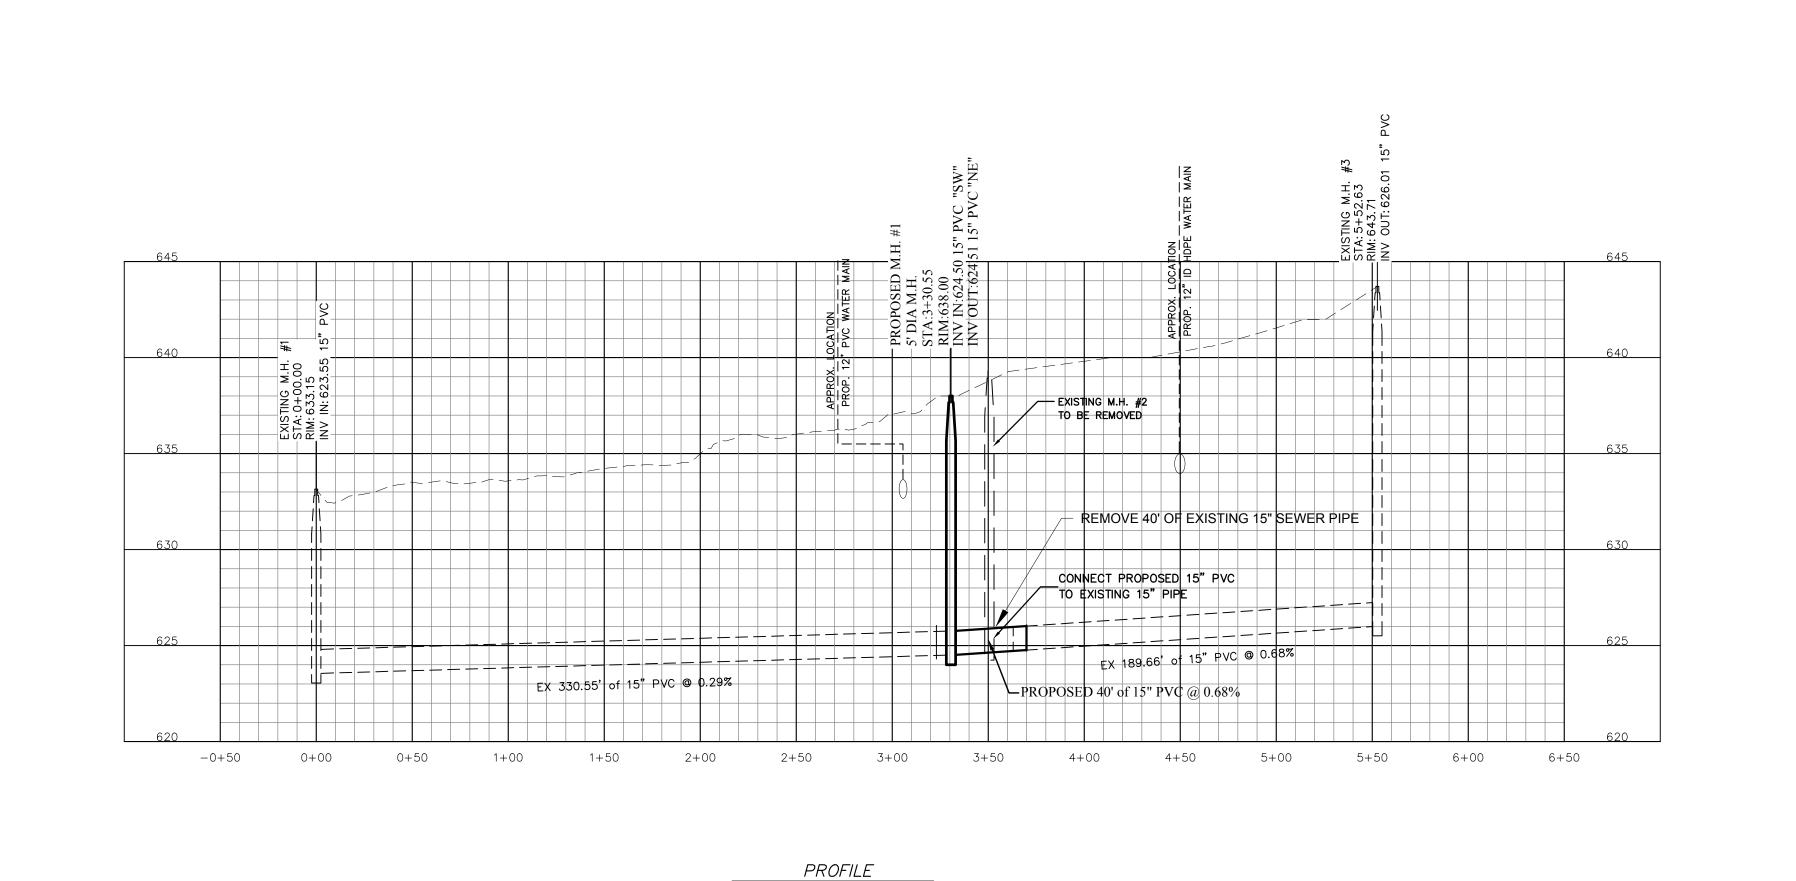

HORZ: 1" = 50' VERT: 1" = 5'

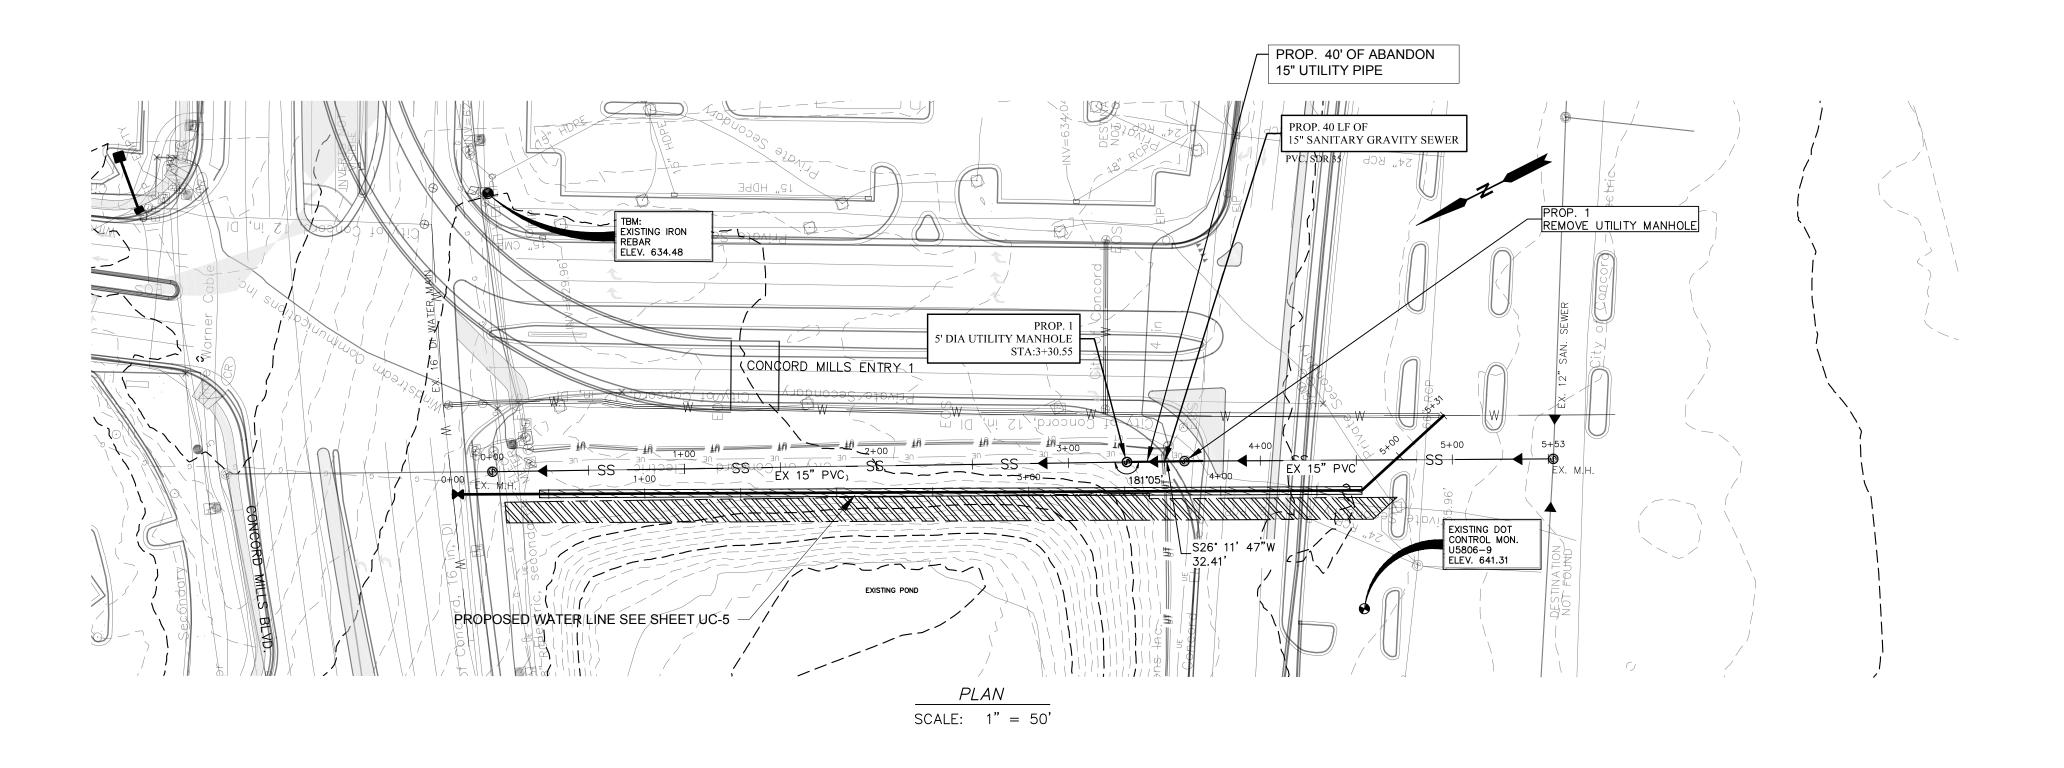

PROJECT REFERENCE NO. SHEET NO. U-5806 UC-4

DESIGNED BY: CMS
DRAWN BY: EES
CHECKED BY: CMS
APPROVED BY:
DATE: 12/08/2016
REVISED:

UTILITIES UNIT
UTILITIES ENGINEERING
SECTION

1555 MAIL SERVICES CENTER RALEIGH NC 27699-1555 PHONE (919) 707-6690 FAX (919) 250-4151

UTILITY CONSTRUCTION

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PREPARED BY
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